

NOTE REFERENCES

EXISTING CONSTRUCTION

- (L) INSULATED FINISHED CORRUGATED STEEL CLADDING SYSTEM (TO MATCH EXISTING)
- (M) CORRUGATED TRANSLUCENT SKYLIGHT PANEL

NEW CONSTRUCTION

- (9) INSULATED FINISHED CORRUGATED STEEL CLADDING SYSTEM (TO MATCH EXISTING)
- (10) CORRUGATED TRANSLUCENT SKYLIGHT PANEL (TO MATCH EXIST.)
- (13) CONC. CURB (W x H)
- (15) PREFINISHED STEEL FLASHING (BY CLADDING SUPPLIER)
- (17) 64mm CONC. WEARING SLAB ON 6MIL. POLYURETHANE SLIP SHEET ON 75mm RIGID INSULATION
- (20) 2 PLY SBS ROOFING
- (21) 2 PLY SBS ROOFING ON 100mm RIGID INSULATION ON VAPOUR RETARDANT
- (23) PREFINISHED CORRUGATED STEEL CLADDING ON STRUCTURAL STEEL SUPPORT FRAMING
- (25) CONCRETE SURFACE SEALER (REFER TO STRUCT. SPEC.)
- (26) CONTINUOUS SEALANT & BACK-UP ROD.
- (31) GALV. STEEL GUARDRAIL (REFER MECH. DWGS.)
- (62) SHEET METAL DUCT (REFER MECH. DWGS.)
- (75) GALV. STEEL ACCESS LADDER (REFER MECH. DWGS.)

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ISSUE	DATE	DRAWN	CHK'D	APP'D	DESCRIPTION	ISSUE	DATE	DRAWN	CHK'D	APP'D	DESCRIPTION
B	APR/96	E.S.	C.O.	C.O.	ISSUED FOR CONSTRUCTION INCLUDES ADDENDA ITEMS						

DESIGNED: D.K.M.
DRAWN: B.D.C.
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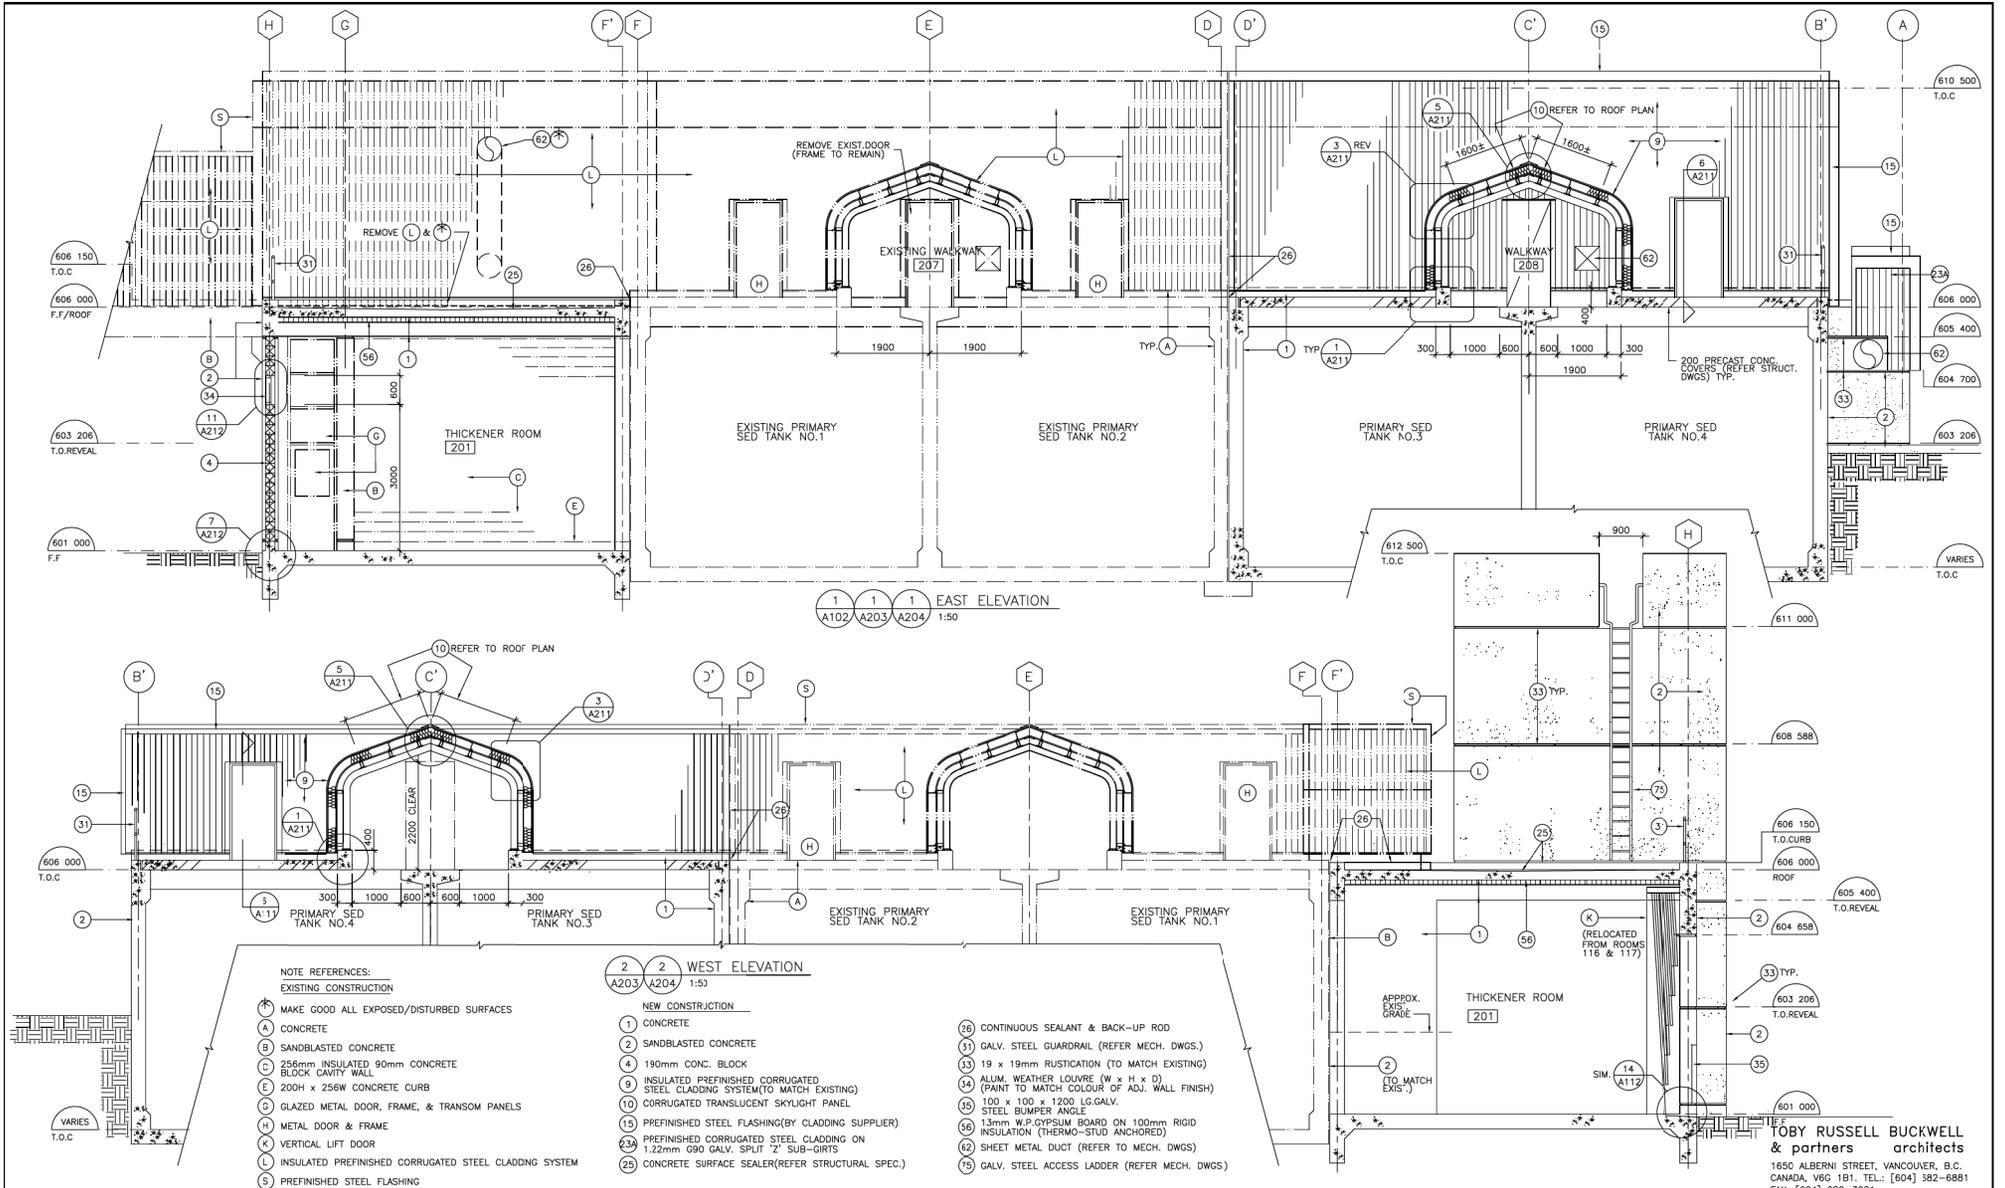
DAYTON & KNIGHT LTD.
Consulting Engineers

RESORT MUNICIPALITY OF WHISTLER
WASTEWATER TREATMENT PLANT-STAGE III EXPANSION - CONTRACT 1
HEADWORKS & PRIMARY SED. TANKS
ROOF PLAN

SCALE: 1:100
DRAWING No. 179.11.1
SHEET 45 OF 249 ISSUE B

TOBY RUSSELL BUCKWELL & partners architects
1650 ALBERNI STREET, VANCOUVER, B.C.
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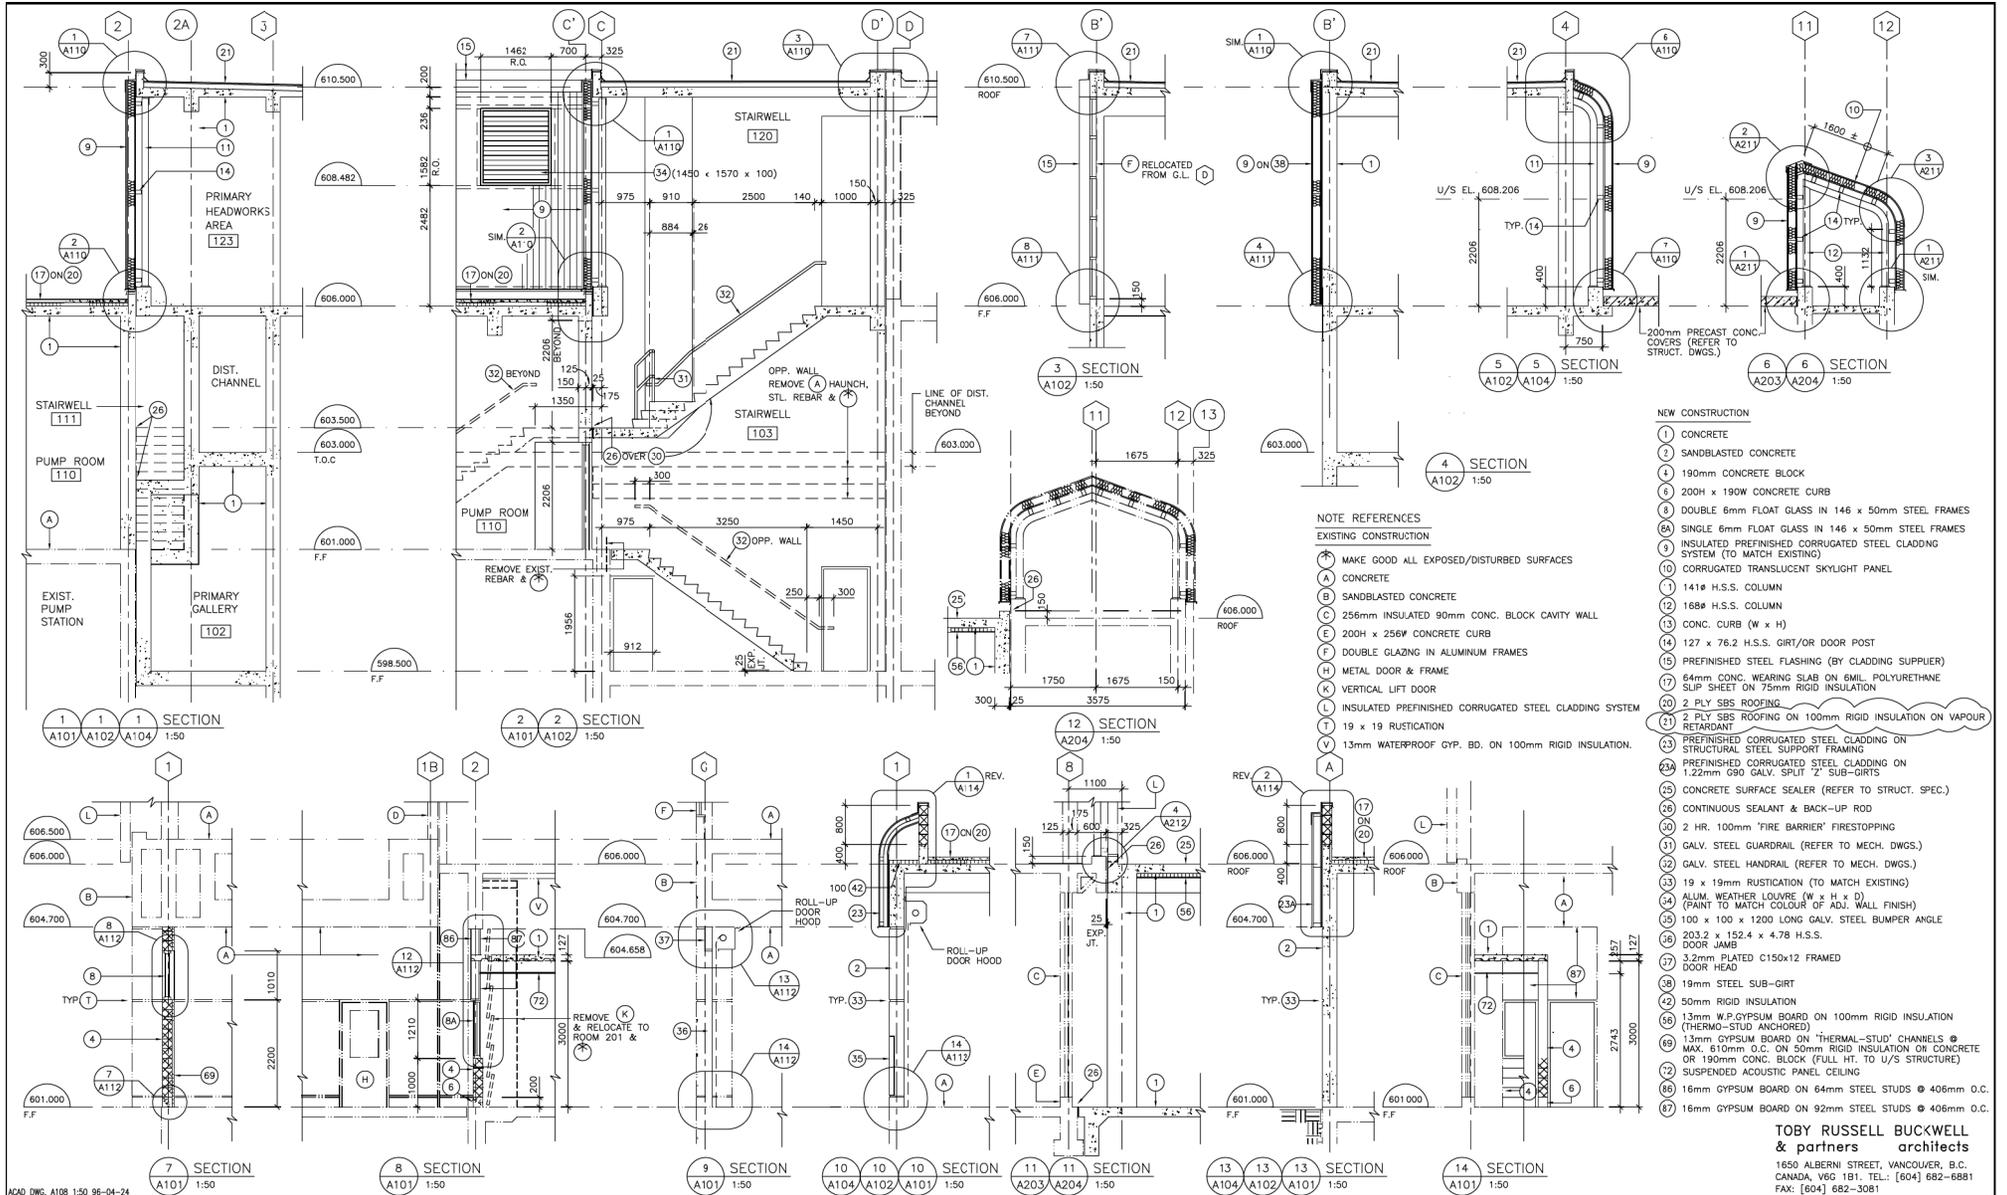
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 CHECKED: C.O.



RESORT MUNICIPALITY OF WHISTLER
 WASTEWATER TREATMENT PLANT-STAGE III EXPANSION - CONTRACT 1
 HEADWORKS & PRIMARY SED. TANKS
 EAST & WEST ELEVATION

SCALE: 1:50
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 SHEET 46 OF 249 ISSUE B
 A107/A207

TOBY RUSSELL BUCKWELL & partners architects
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- NOTE REFERENCES**
- EXISTING CONSTRUCTION**
- (*) MAKE GOOD ALL EXPOSED/DISTURBED SURFACES
 - A CONCRETE
 - B SANDBLASTED CONCRETE
 - C 256mm INSULATED 90mm CONC. BLOCK CAVITY WALL
 - D 200H x 256W CONCRETE CURB
 - E DOUBLE GLAZING IN ALUMINUM FRAMES
 - H METAL DOOR & FRAME
 - K VERTICAL LIFT DOOR
 - L INSULATED PREFINISHED CORRUGATED STEEL CLADDING SYSTEM
 - N 19 x 19 RUSTICATION
 - V 13mm WATERPROOF GYP. BD. ON 100mm RIGID INSULATION.
- NEW CONSTRUCTION**
- 1 CONCRETE
 - 2 SANDBLASTED CONCRETE
 - 3 190mm CONCRETE BLOCK
 - 4 200H x 190W CONCRETE CURB
 - 5 DOUBLE 6mm FLOAT GLASS IN 146 x 50mm STEEL FRAMES
 - 6 SINGLE 6mm FLOAT GLASS IN 146 x 50mm STEEL FRAMES
 - 7 INSULATED PREFINISHED CORRUGATED STEEL CLADDING SYSTEM (TO MATCH EXISTING)
 - 8 CORRUGATED TRANSLUCENT SKYLIGHT PANEL
 - 9 141H H.S.S. COLUMN
 - 10 168H H.S.S. COLUMN
 - 11 CONC. CURB (W x H)
 - 12 127 x 76.2 H.S.S. GIRT/OR DOOR POST
 - 13 PREFINISHED STEEL FLASHING (BY CLADDING SUPPLIER)
 - 14 64mm CONC. WEARING SLAB ON 6mm POLYURETHANE SLIP SHEET ON 75mm RIGID INSULATION
 - 15 2 PLY SBS ROOFING
 - 16 2 PLY SBS ROOFING ON 100mm RIGID INSULATION ON VAPOUR RETARDANT
 - 17 PREFINISHED CORRUGATED STEEL CLADDING ON STRUCTURAL STEEL SUPPORT FRAMING
 - 18 PREFINISHED CORRUGATED STEEL CLADDING ON 1.22mm G90 GALV. SPLIT 2" SUB-GIRTS
 - 19 CONCRETE SURFACE SEALER (REFER TO STRUCT. SPEC.)
 - 20 CONTINUOUS SEALANT & BACK-UP ROD
 - 21 2 HR. 100mm "FIRE BARRIER" FIRESTOPPING
 - 22 GALV. STEEL GUARDRAIL (REFER TO MECH. DWGS.)
 - 23 GALV. STEEL HANDRAIL (REFER TO MECH. DWGS.)
 - 24 19 x 19mm RUSTICATION (TO MATCH EXISTING)
 - 25 ALUM. WEATHER LOUVER (W x H x D) (PAINT TO MATCH COLOUR OF ADJ. WALL FINISH)
 - 26 100 x 100 x 1200 LONG GALV. STEEL BUMPER ANGLE
 - 27 203.2 x 152.4 x 4.78 H.S.S. DOOR JAMB
 - 28 3.2mm PLATED C150x12 FRAMED DOOR HEAD
 - 29 19mm STEEL SUB-GIRT
 - 30 50mm RIGID INSULATION
 - 31 13mm W.P. GYPSUM BOARD ON 100mm RIGID INSULATION (THERMO-STUD ANCHORED)
 - 32 13mm GYPSUM BOARD ON "THERMAL-STUD" CHANNELS @ MAX. 610mm O.C. ON 50mm RIGID INSULATION ON CONCRETE OR 190mm CONC. BLOCK (FULL HIT. TO U/S STRUCTURE)
 - 33 SUSPENDED ACOUSTIC PANEL CEILING
 - 34 16mm GYPSUM BOARD ON 64mm STEEL STUDS @ 406mm O.C.
 - 35 16mm GYPSUM BOARD ON 92mm STEEL STUDS @ 406mm O.C.

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